


KEY PLAN - SCALE 1:5000

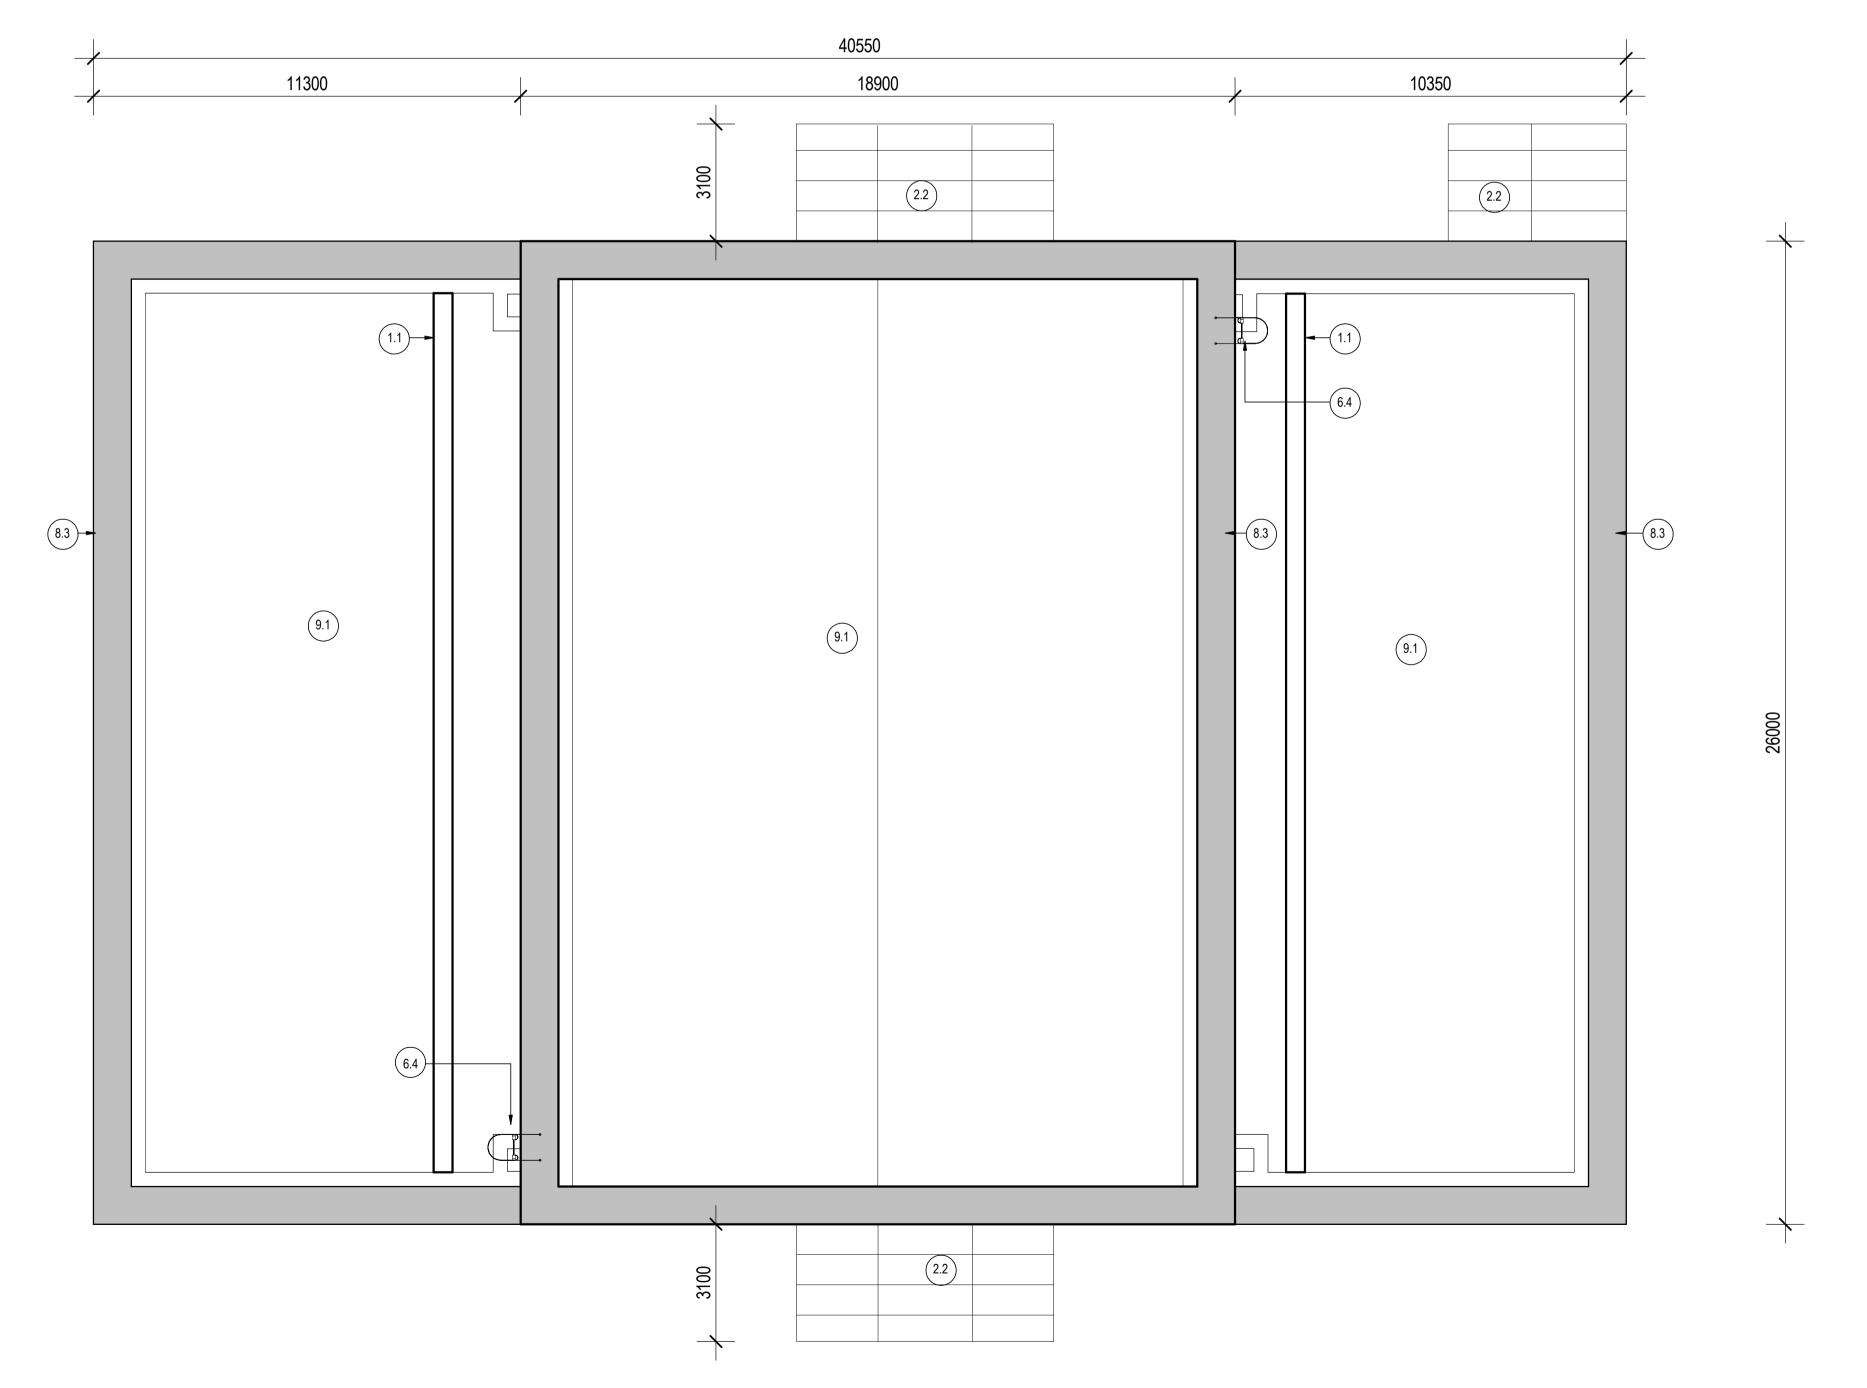

INTERNAL BUSINESS COLLABORATOR REFERENCE HPC-NNBPCP-U0-HUM-DRW-000001

Materials Key Vertical Enclosure - Wall

- 1 Concrete/ render finishes 1.1 In-situ concrete
- 1.2 Pre-cast concrete1.3 Render finish
- 2 Cladding

- 2.1 Aluminium standing seam
 2.2 Aluminium panels
 2.3 Aluminium planks
 2.4 Profiled steel panels
 2.5 Flat steel panels
 2.6 Fibre cement cladding
 2.7 Glass reinforced plastic

- 3 Glazing/ transluscent materials
 3.1 Cast glass c-channel
 3.2 Frameless glazing
 3.3 Framed glazing
 3.4 Opaque glazed spandrel panel
 3.5 Polycarbonate transluscent
- 4 External wall features 4.1 Aluminium trims, copings and
- casings
 4.2 Aluminium louvres
 4.3 Glass louvres
- 4.4 Aluminium brise-soleil

cladding

4.4 Adminium brise-soleil
4.5 Glass brise-soleil
4.6 Mesh expanded metal panels
4.7 Fencing
4.8 Barbed tape
4.9 Retractable steel shutters

- 5 Doors
 5.1 Metal door
 5.2 Metal louvre door
 5.3 Glazed door
 5.4 Access gates

- Window/ metalwork accessories
- External fabric blinds Cavity venetian blinds Glazed balustrade
- 6.4 Metal stairs and ladders
- Horizontal Enclosure Roof
- 7. Roofing
 7.1 Sedum roof
 7.2 Ballast
 7.3 Standing seam roof
 7.4 Concrete roof

- 8 Roofing accessories
 8.1 Roof light
 8.2 Roof vents and hatches
- 8.3 Metal cappings and copings
 8.4 Paving
 8.5 PVs and solar panels
 8.6 Timber decking

- 9 Additional Materials9.1 Bitumen roof

01 JUNE 2020 GA GA PERMANENT DEVELOPMENT DCO CHANGE SUBMISSION REVISION DATE DRAWN CHECKED



HINKLEY POINT C

Hinkley Point C Development Site Emergency Response Centre (HUM)

Roof Plan

Regulation 5(2)(o)

PROJECT DRAWING REFERENCE NO. HINK-A2-HUM-00-GP-020

01 1:100 @ A1 JUN 2020

DCO Change Application Drawing - Detail (for Approval)

DRAWING SECURITY CLASSIFICATION

PROTECTIVE MARKING REQUIRED

NOT PROTECTIVELY MARKED